
SITE PLAN OF LOT 21, BLOCK B, SECTION 11, ESQUIMALT DISTRICT, PLAN 292.

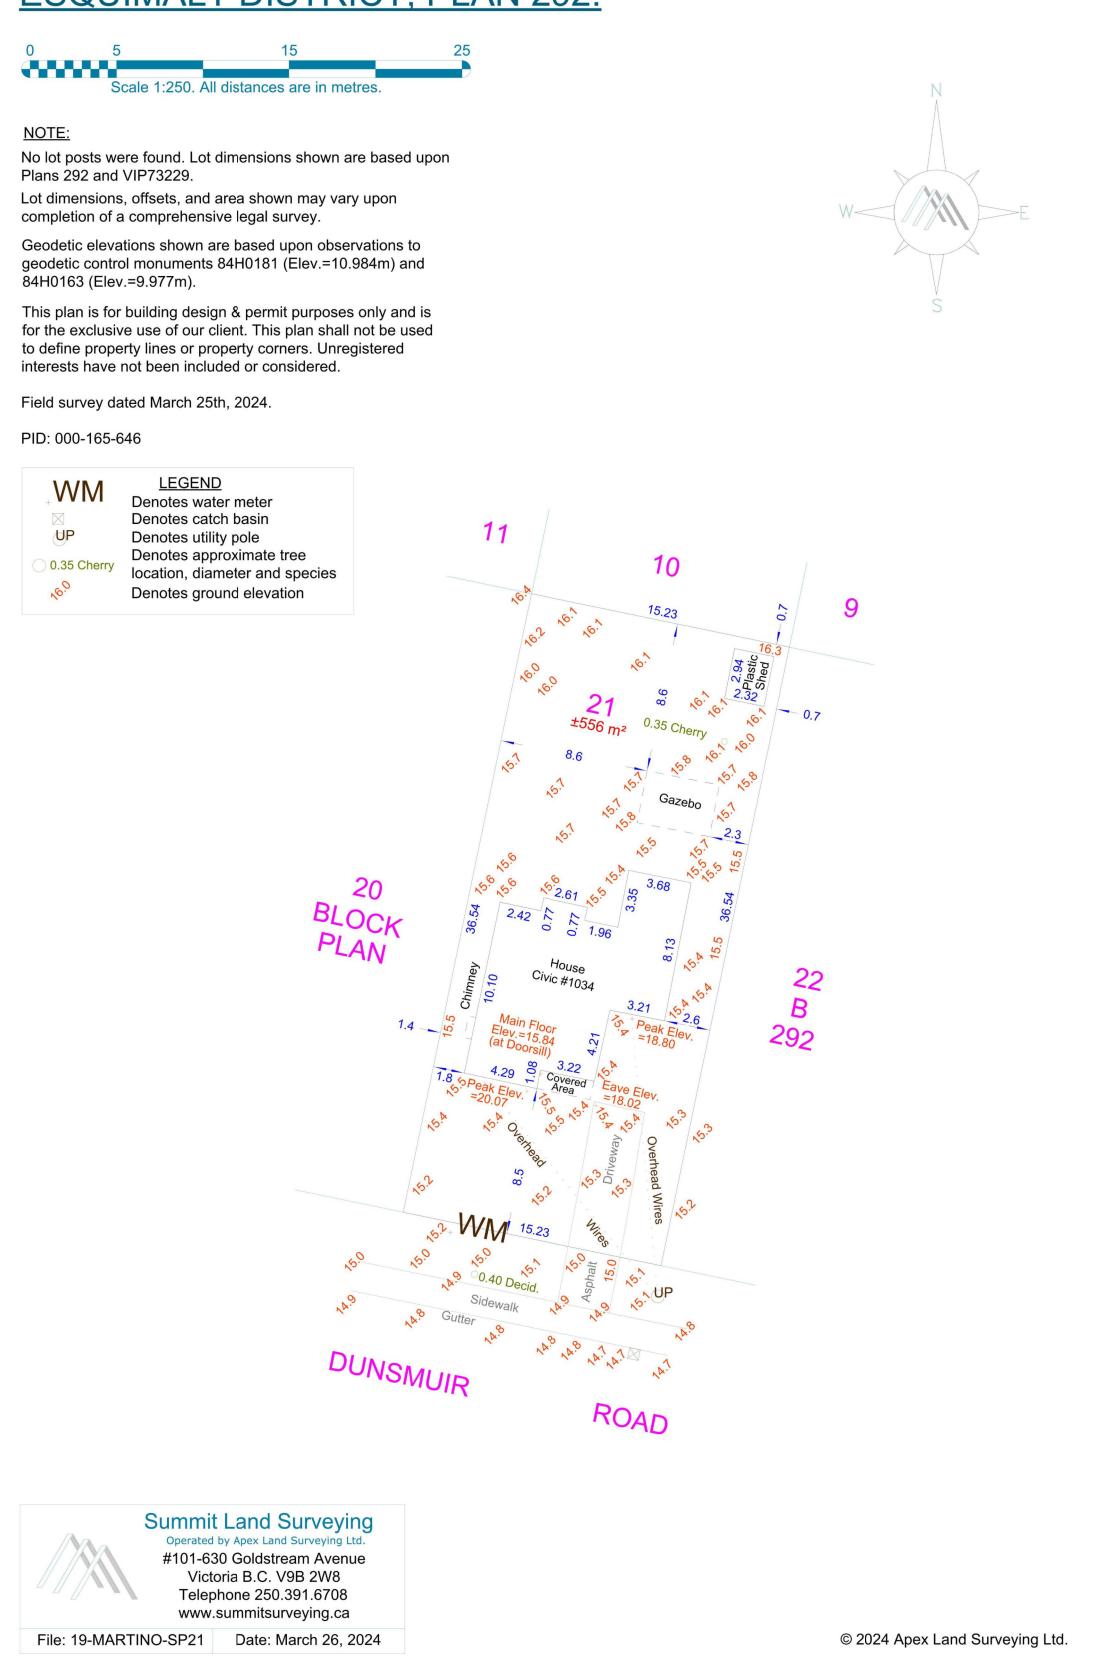

NOTE: SURVEY NOT SCALE

GENERAL NOTES

- ALL WORK SHALL COMPLY TO THE CURRENT (2018) EDITION OF THE BRITISHCOLUMBIA BUILDING CODE AND SHALL MEET OD EXCEED THE MINIMUM REQUIREMENTS AS SET BY THOSE HAVING JURISDICTION.

- ERRORS, OMISSIONS OR CHANGES TO THESE PLANS ARE TO BE REPORTED TO THE DESIGNER PROMPTLY PRIOR TO ANY FURTHER WORK TAKING PLACE. - STRUCTURAL DESIGN & SUPERVISION SHALL BE PERFORMED BY A CERTIFIED STRUCTURAL ENGINEER CERTIFIED IN THE

PROVINCE OF BRITISH COLUMBIA AT THE REQUEST OF THE LOCAL BUILDING AUTHORITY. FOUNDATIONS TO BE VERIFIED CORRECT BY A STRUCTURAL ENGINEER UNLESS OTHERWISE APPROVED BY THE BUILDING INSPECTION AUTHORITY.

- ALL FOUNDATIONS ARE ASSUMED BEARING ON NON-ORGANIC UNDISTURBED SOIL. - POINT LOADS TO BE SUPPORTED CONTINUOS TO FOUNDATION. - DOUBLE JOISTS OR SOLID CROSS BLOCKS AT WALL LOCATIONS RUNNING PARALLEL TO FLOOR JOISTS. - LINTELS TO BE 3-PLY 2"x10" SPF#2 OR AS NOTED.

- BUILDING ENVELOPE DESIGN TO BE BASED ON CURRENT GOOD BUILDING PRACTICES. FIELD INSPECTIONS ARE THE RESPONSIBILITY OF THE OWNER.

PREMANUFACTURED FLOOR JOISTS, BEAMS AND TRUSSES TO BE REVIEWED BY SUPPLIER'S ENGINEER AND CERTIFIED FOR STRUCTURAL ADEQUACY. SUPPORTING COLUMNS TO BE DESIGNED BY A STRUCTURAL ENGINEER AT THE REQUEST OF THE LOCAL BUILDING INSPECTION AUTHORITY. ENGINEERED ROOF TRUSSES, FLOOR JOIST AND BEAM SYSTEM LAYOUTS TO BE PROVIDED WITH SHOP DRAWINGS FOR PERMIT

SUBMISSION - 110 VOLT INTERCONNECTED SMOKE DETECTOR & CARBON MONOXIDE DETECTOR THESE DRAWINGS ARE BASED ON PART 9 OF THE 2018 BCBC - DUCTING, FURNACE, HOT WATER HEATER TO BE LOCATED WITHIN CONDITIONED AREAS. - INSULATION VALUES TO MEET THE EFFECTIVE R-VALUES AS NOTED IN BCBC 9.36.2.6.-9.36.2.8. ANS AS REQUIRED BY THOSE HAVING JURISDICTION.


HEATING AND VENTILATION TO MEET NEW MINIMUM CODE REQUIREMENTS UNLESS NOTED OTHERWISE.

- ALL CHASE WAYS, DUCTING & PIPING LOCATED IN NON-CONDITIONED AREAS MUST HAVE THE MINIMUM EFFECTIVE R-VALUE OF INSULATION BETWEEN IT AND THE UNCONDITIONED SPACE OR EXTERIOR. - ATTIC VENTILATION SHALL ADHERE TO 9.19.1.2. (VENTILATION REQUIREMENTS) OF BCBC.

- LIGHTING BY OTHERS. - CONCRETE TO REACH 3000 P.S.I. AFTER 28 DAYS - ALL STRUCTURAL LUMBER TO BE NO.2 OR BETTER. - DESIGNER IS NOT RESPONSIBLE FOR THE STRUCTURE, OR ANY FAILURE OF THE STRUCTURE. - FANS TO BE RATED FOR CONTINUOUS USE WITH A NOISE LEVEL OF 2.5 SONES (60dBa) OR LESS. - ALL BATHROOMS AND KITCHENS TO BE EQUIPPED WITH

AN EXHAUST FAN CAPABLE OF EXHAUSTING 60 CFM. - ELECTRICAL & PLUMBING WORK TO CONFORM TO THE REPECTIVE CODES. - CONTRACTOR TO CONFIRM ALL LEVELS & DIMENSIONS

BEFORE COMMENCING WITH CONSTRUCTION. - THRMO-PANE WINDOWS THROUGHOUT C/W SCREENS ON ALL OPENERS.

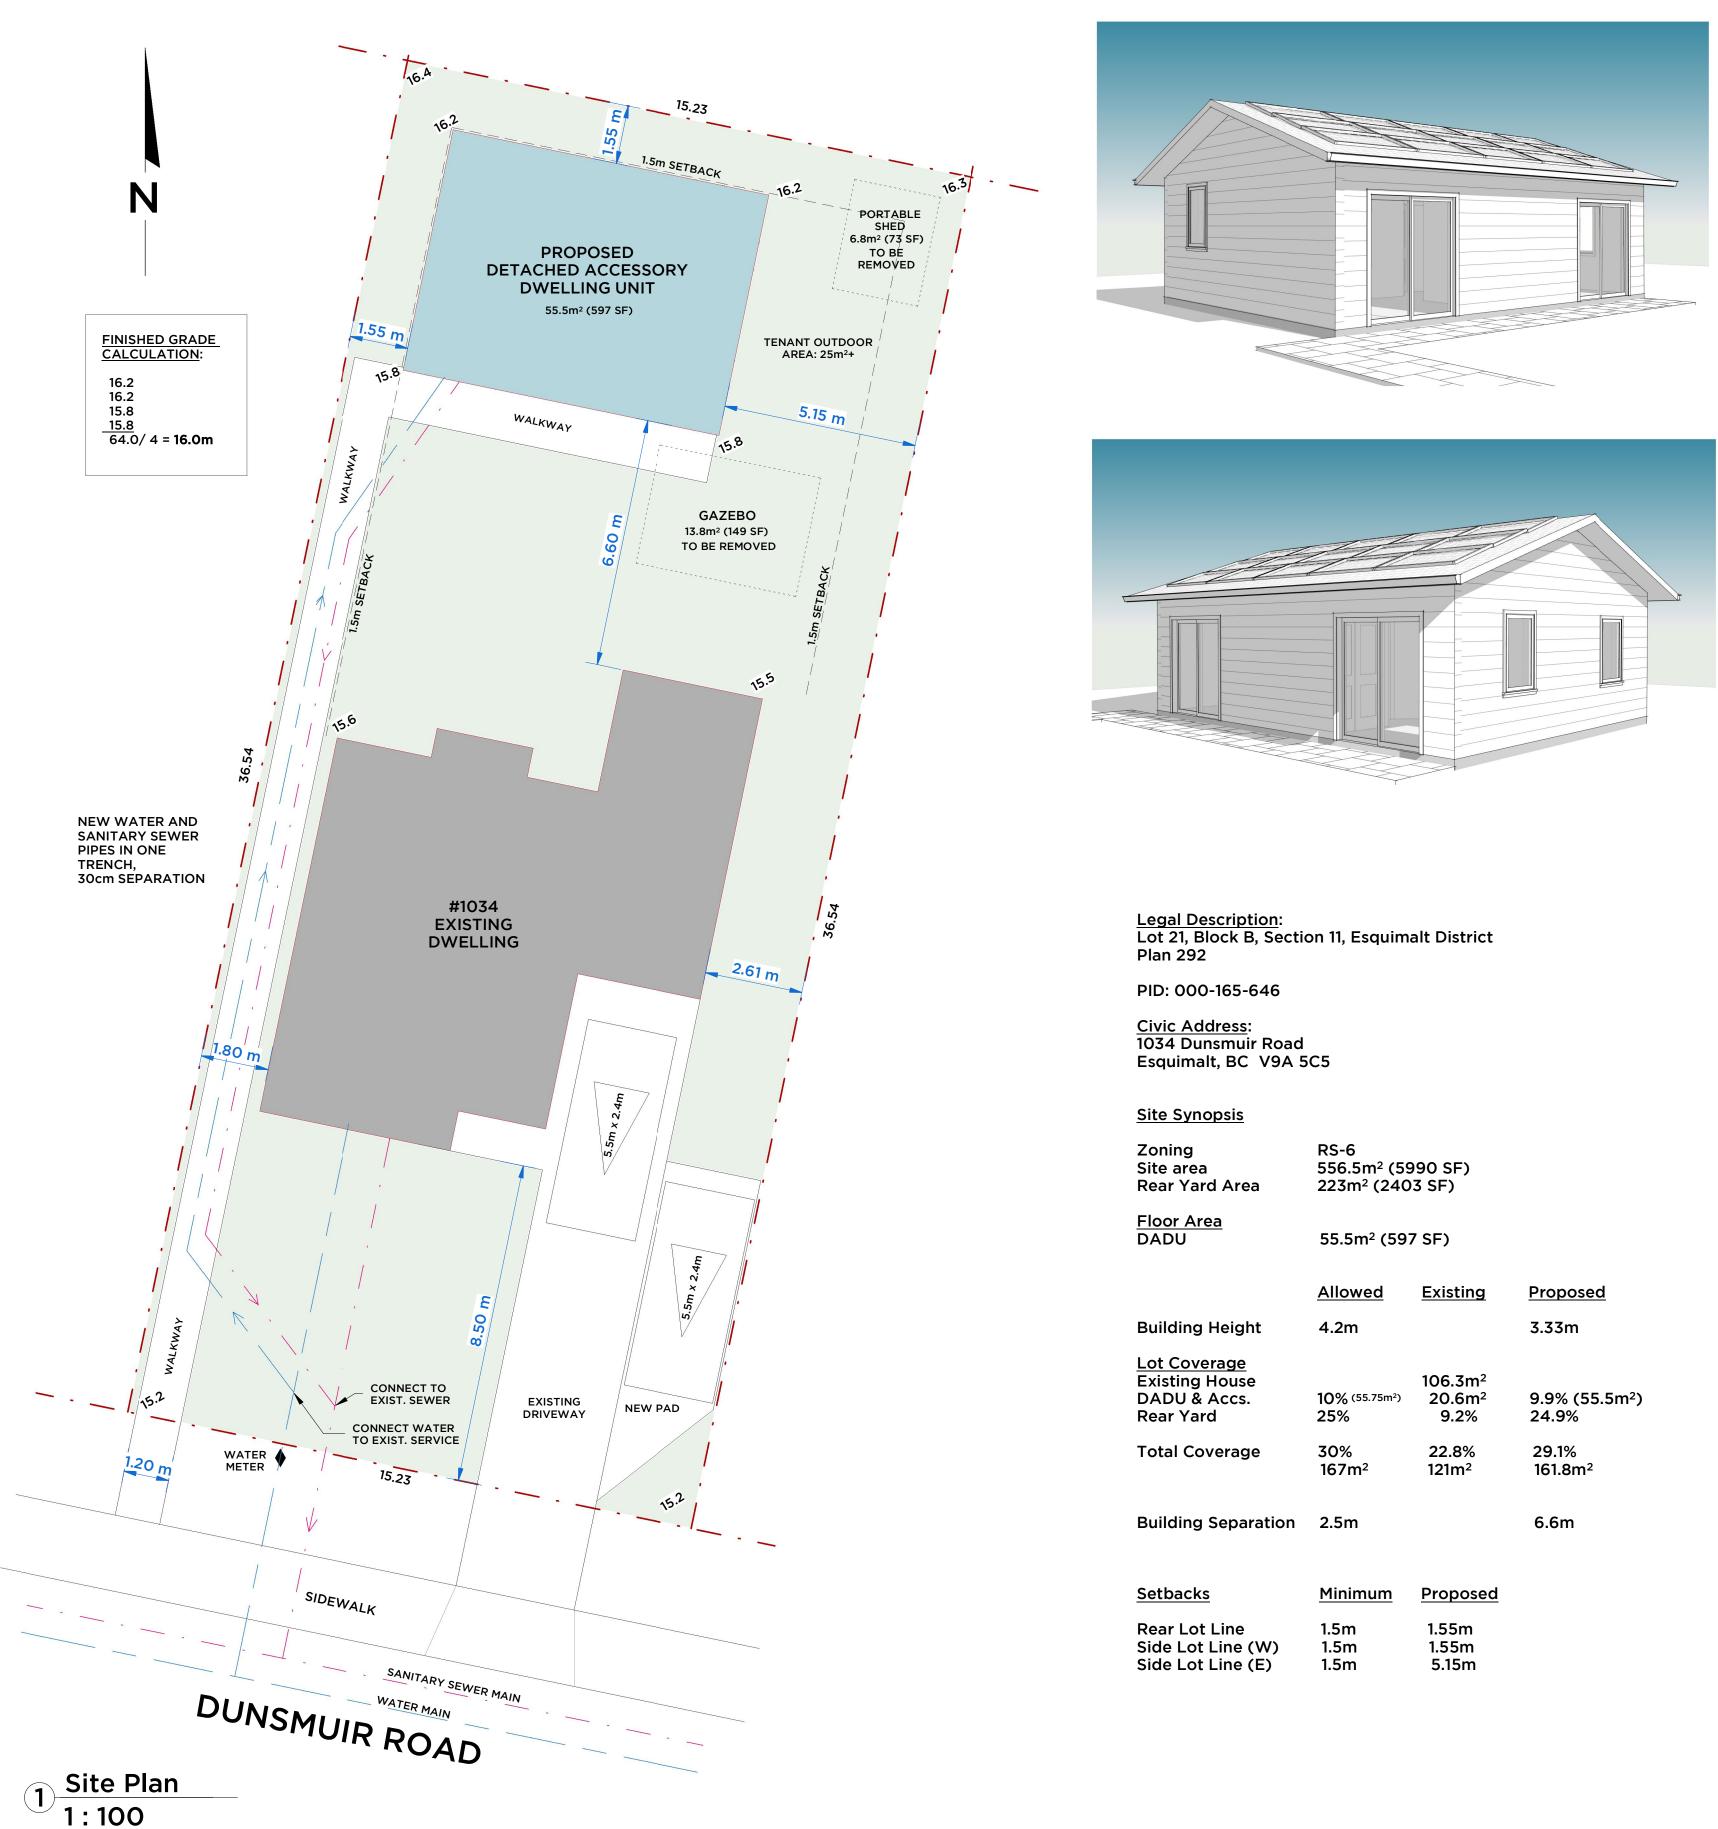

- Notes

- Vapour barrier to be continuous and U.V. stabalised. - Provide two coats of bisthumus sealant on all sub-grade concrete' - Floor assembly to accommodate plumbing.
- Confirm all door and window rough openings before ordering product. Framing Notes:
- Wall sheathing shall extend 1" past topo of slab.
- The sheathing lap is to be fastened every 6" with 2 1/4" nails. - Sheathing shall completely lap the adjoining wall at the intersection of the corners. - All built-up posts at point loads: each ply is to be nailed with 2 rows of 3" d nails @ 10" o.c. to within 6' of each end.
- Freestanding solid posts: - Posts shall be anchored to the beams they support by either-1. Notching the beam over the post and securely nailing or bolting
- the beam to the post. (depending on configuration and load) or 2. Provide approved suitable metal anchors to connect the two.

TYPICAL NOTES

- CONTRACTOR TO REPORT ALL ERRORS OR EMISSIONS IMMEDIATELY & PRIOR TO THE COMMENCEMENT OF THE WORK.
- 2. ANY DISCREPENCIES TO BE BROUGHT TO THE OWNER'S ATTENTION PRIOR TO CONTINUING ANY PORTION OF
- WORK. SEE STRUCTURAL DRAWINGS FOR ALL FOUNDATIONS,
- CONC. WALLS & SLABS, WOOD JOISTS & BEAM SIZES. 4. CONCRETE WALL DIMENSIONS ARE TO OUTSIDE OF FACE. WOOD FRAME WALLS ARE TO CENTERLINE.
- 5. DIMENSIONS ARE IN IMPERIAL UNO.
- 6. PROVIDE MISCELLANEOUS STUDS, BRACING, FURRING OR BLOCKING AS REQUIRED.
- MAINTAIN ACOUSTIC SEPARATION @ RECESSED FIXTURES
- & EQUIPMENT.
- 8. CEMENT BOARD TO BE USED @ ALL WET WALLS. 9. CONFIRM WINDOW AND DOOR ROUGHOPEN SIZES WITH SUPPLIEERS. SIZES ON DRAWINGS ARE NOMINAL. OPENER STYLES & LOCATIONS TO BE DETERMINED BY OWNER.

g	RS-6
rea	556.5m² (5990 S
Yard Area	223m ² (2403 SF)

DU	55.5m² (59)	7 SF)	
	Allowed	Existing	<u>Proposed</u>
ding Height	4.2m		3.33m
<u>Coverage</u> ting House DU & Accs. r Yard	10% (55.75m²) 25%	106.3m² 20.6m² 9.2%	9.9% (55.5 24.9%
al Coverage	30% 167m²	22.8% 121m²	29.1% 161.8m²

backs	<u>Minimum</u>	-
r Lot Line	1.5m	
Lot Line (W)	1.5m	
Lot Line (E)	1.5m	



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Project Name:


Detached Accessory **Dwelling Unit**


1034 DUNSMUIR Road Esquimalt, BC V9A 5C5


Cover - Site


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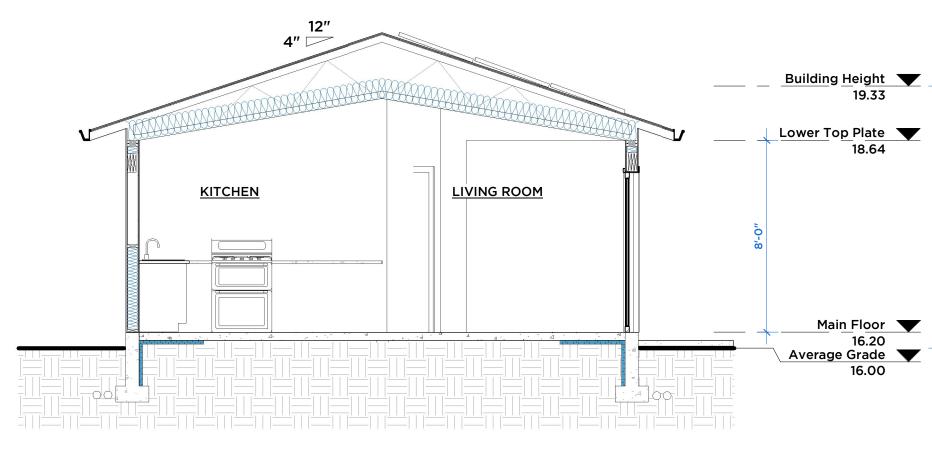
Sheet List	
Sheet Number	Sheet Name
	1
A1	Cover - Site
A2	Plan Views & Section
A3	Elevations
A4	Lateral Bracing & Details




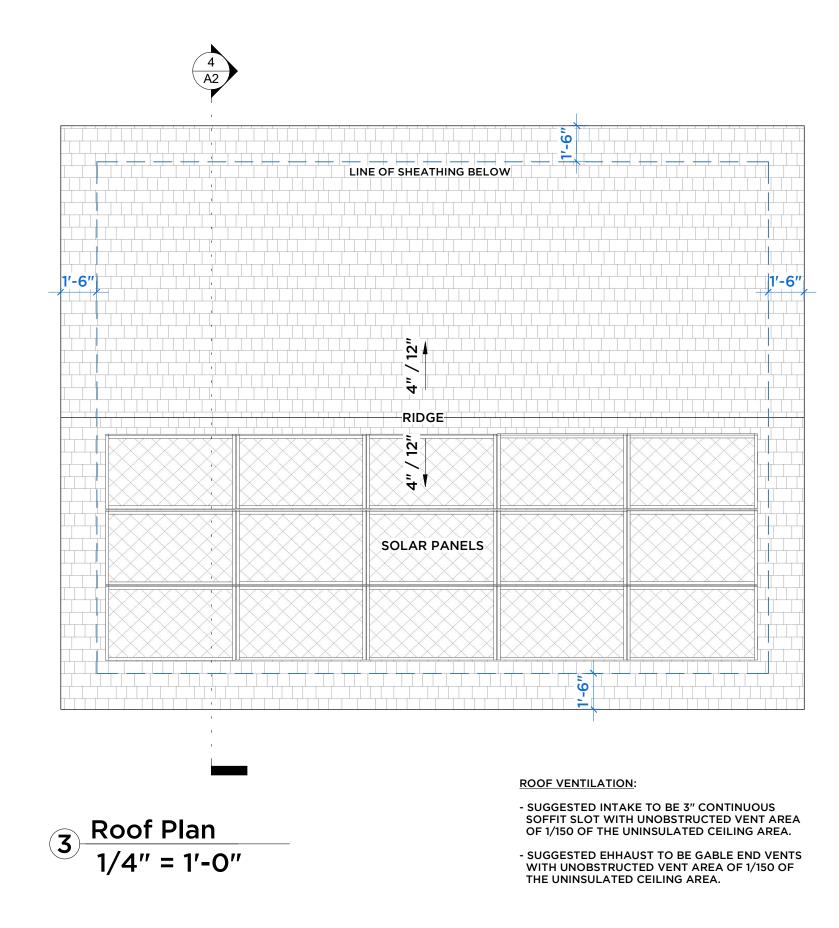

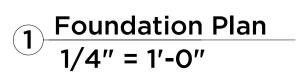

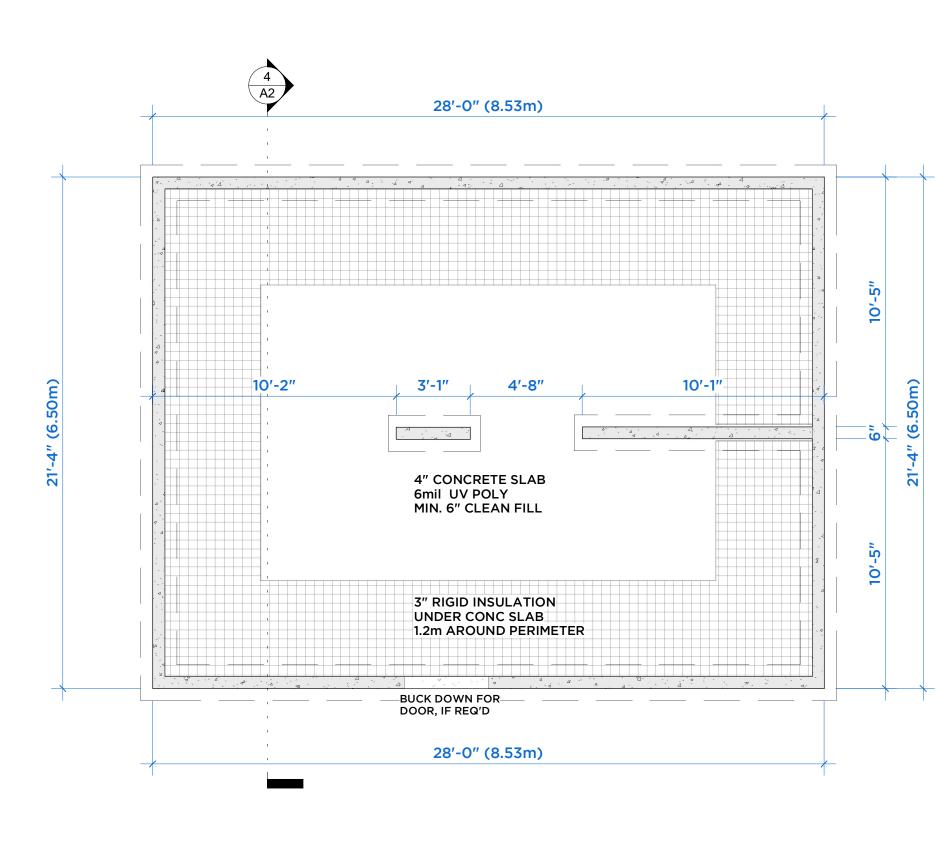

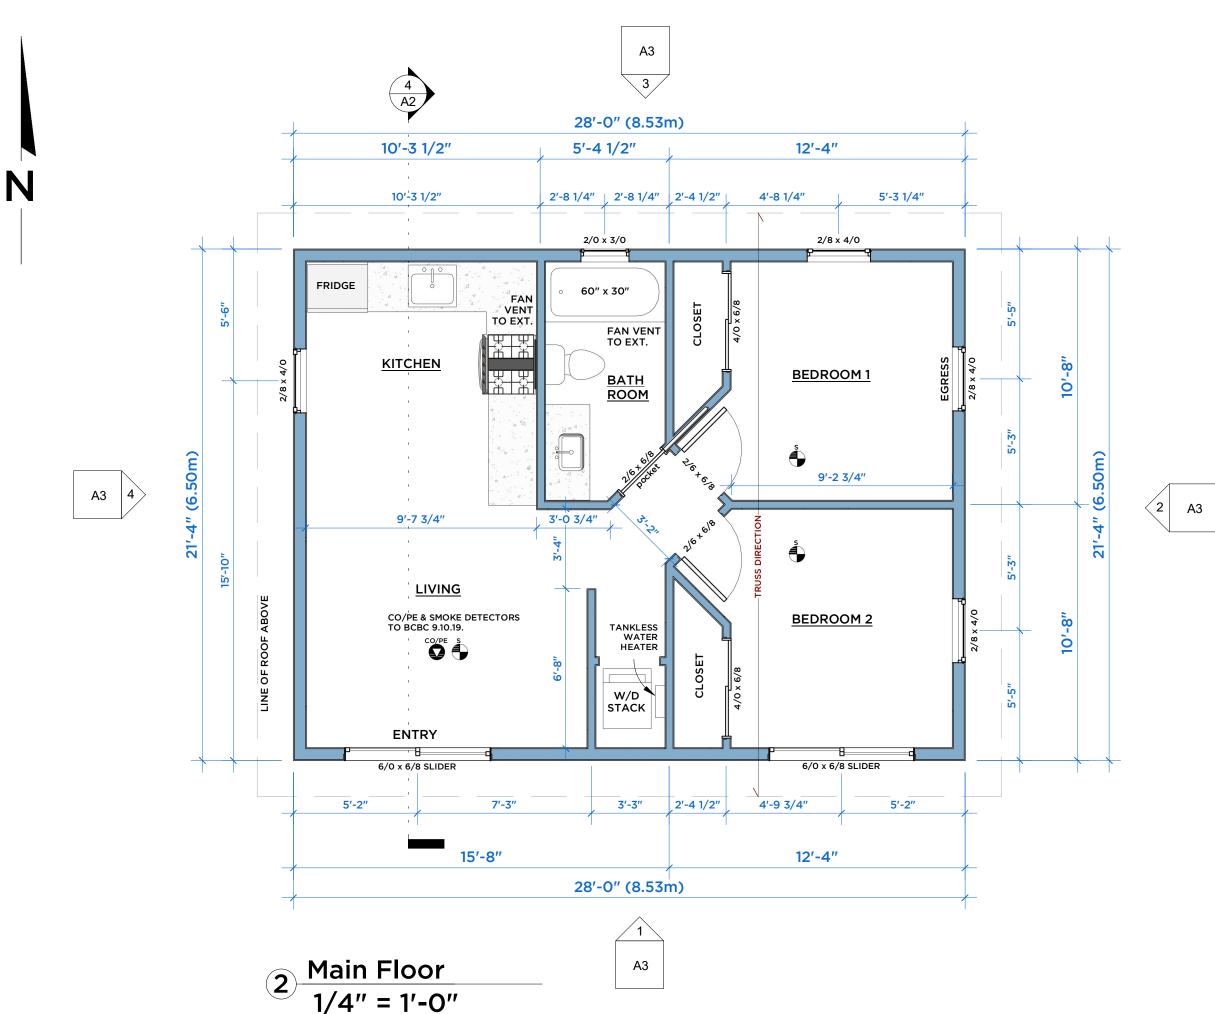

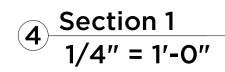





CONSTRUCTION ASSEMBLIES

FOUNDATIONS

- FOUNDATION WALLS: 2 COATS DAMP-PROOFING 6" CONCRETE WALL R/W 10M REBAR @ 24" O/C E/W 16"x8" CONCRETE FOOTING R-12 RIGID INSULATION

INTERIOR CURB WALLS: - 6" CONCRETE CURB WALL - 16"x8" CONCRETE FOOTING


WALLS

- EXTERIOR WALLS: SIDING AS PER CLIENT 3/8" x 1 1/2" PT STRAPPING VAPOUR-OPEN HOUSE WRAP 1/2 PLYWOOD SHEATHING SHEATHING 2X6" WOOD STUDS @ 16" O/C R22 BATT INSULATION 6MIL UV POLY 1/2" DRYWALL
- 1/2" DRYWALL

<u>INTERIOR DIVIDER WALLS</u>: - 1/2" DRYWALL - 2X4" WOOD STUDS @ 16" O/C - 1/2" DRYWALL

- FLOOR: FLOORING SURFACE AS PER OWNER 4" CONCRETE SLAB 6MIL UV POLY R-12 RIGID INSULATION 1.2m AROUND PERIMETER MIN. 6" CLEAN FILL

- ROOF: ASPHALT ROOFING SHINGLES ROOF UNDERLAYMENT 1/2" PLYWOOD T&G SHEATHING SCISSOR TRUSSES @ 24" O/C **SOLAR PANEL READY* R-40 BATT INSULATION 1/2" DRYWALL

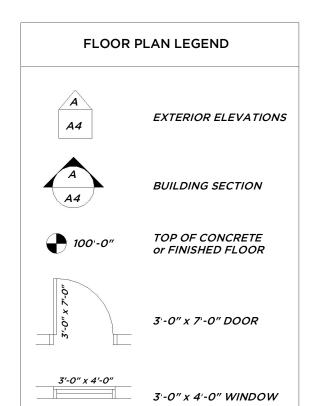

CO/PE & SMOKE DETECTORS TO BCBC 9.10.19.

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Project Name:

Detached Accessory Dwelling Unit

1034 DUNSMUIR Road Esquimalt, BC V9A 5C5

Plan Views & Section


Drawing No.
A2

File Name:





1 FRONT (South) 1/4" = 1'-0"

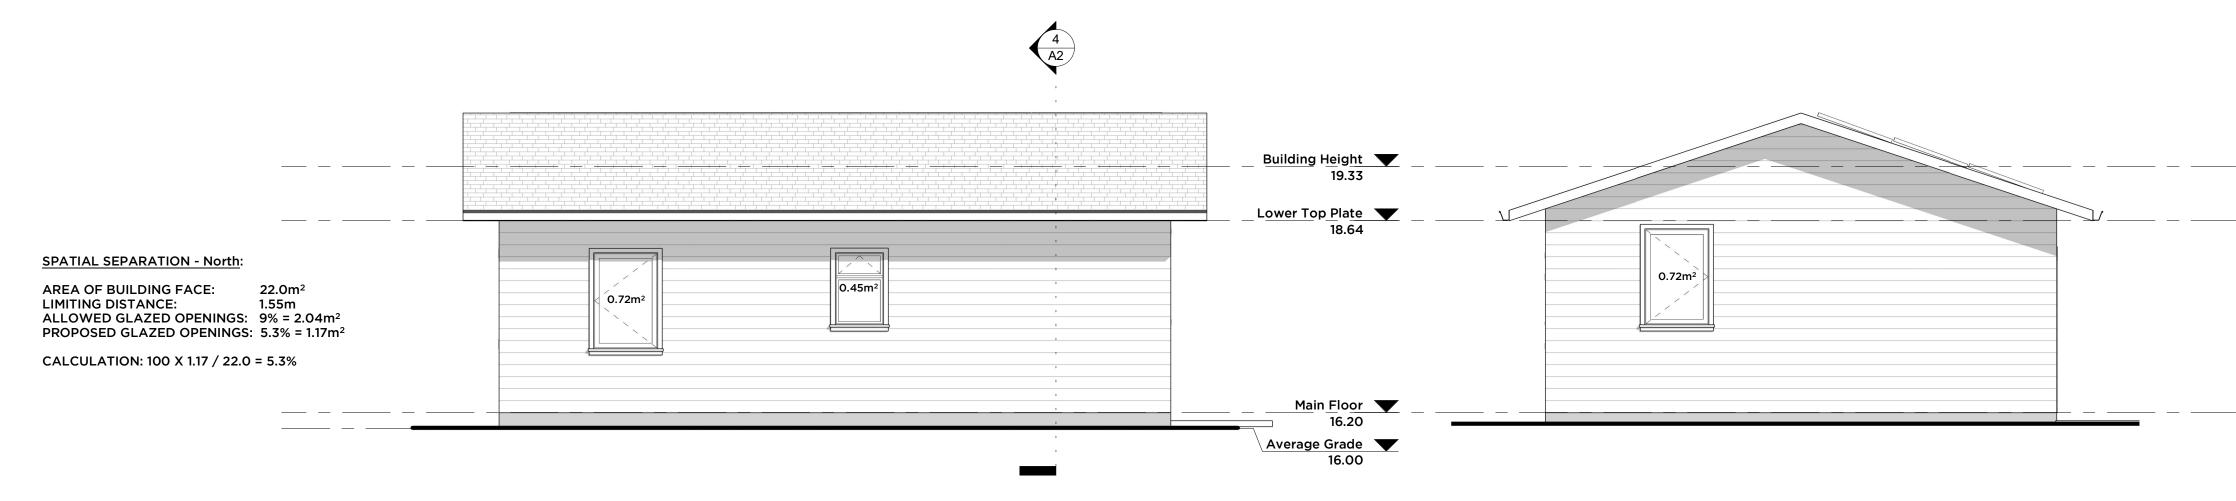

3 REAR (North) 1/4" = 1'-0" 2 RIGHT (East) 1/4" = 1'-0"

4 LEFT (West) 1/4" = 1'-0"



AREA OF BUILDING FACE: 20.5m² LIMITING DISTANCE: 5.15m ALLOWED GLAZED OPENINGS: 64% = 13.1m² PROPOSED GLAZED OPENINGS: 7.0% = 1.44m² CALCULATION: 100 X 1.44 / 20.5 = 7.0%

SPATIAL SEPARATION - West:

AREA OF BUILDING FACE:20.5m²LIMITING DISTANCE:1.55mALLOWED GLAZED OPENINGS:9% = 1.8m²PROPOSED GLAZED OPENINGS:3.5% = 0.72m²

CALCULATION: 100 X 0.72 / 20.5 = 3.5%



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Project Name:


Detached Accessory Dwelling Unit

1034 DUNSMUIR Road Esquimalt, BC V9A 5C5

Elevations

File Name:

Scale: as noted	Drawing No.
Drawn by: AJW	
Date: APR. 10, 2024	A3

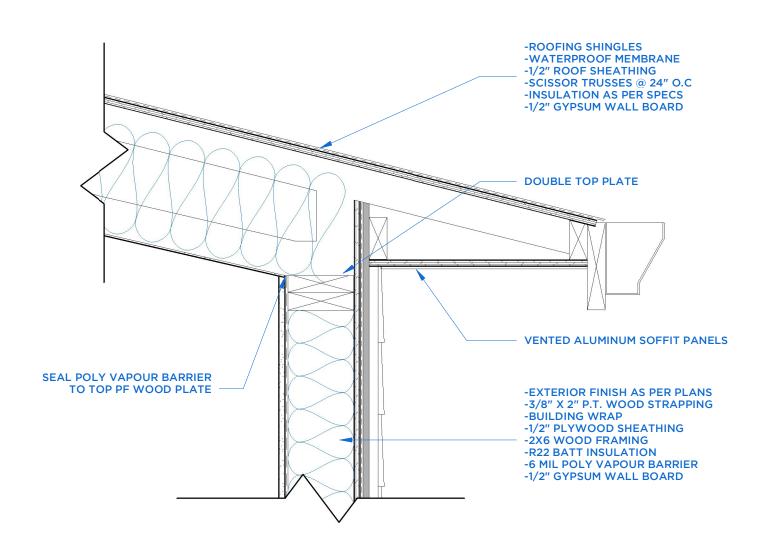

2 Water Shedding Roof/Wall - Typical 11/2" = 1'-0"

